

DEVELOPMENT APPLICATION PDPLANPMTD-2024/044606

PROPOSAL: Warehouse

LOCATION: 2 Lockheed Place, Cambridge

RELEVANT PLANNING SCHEME: Tasmanian Planning Scheme - Clarence

ADVERTISING EXPIRY DATE: 15 July 2024

The relevant plans and documents can be inspected at the Council offices, 38 Bligh Street, Rosny Park, during normal office hours until 15 July 2024. In addition to legislative requirements, plans and documents can also be viewed at www.ccc.tas.gov.au during these times.

Any person may make representations about the application to the Chief Executive Officer, by writing to PO Box 96, Rosny Park, 7018 or by electronic mail to clarence@ccc.tas.gov.au. Representations must be received by Council on or before 15 July 2024.

To enable Council to contact you if necessary, would you please also include a day time contact number in any correspondence you may forward.

Any personal information submitted is covered by Council's privacy policy, available at www.ccc.tas.gov.au or at the Council offices.

Clarence City Council



APPLICATION FOR DEVELOPMENT / USE OR SUBDIVISION

The personal information on this form is required by Council for the development of land under the Land Use Planning and Approvals Act 1993. We will only use your personal information for this and other related purposes. If this information is not provided, we may not be able to deal with this matter. You may access and/or amend your personal information at any time. How we use this information is explained in our **Privacy Policy**, which is available at www.ccc.tas.gov.au or at Council offices.

Proposal:	New Commercial Warehouses				
Location:	Address 2 Lockheed Place Suburb/Town Cambridge Postcode 7170				
Current Owners/s: Applicant:	Personal Information Removed				
Tax Invoice for application fees to be in the name of: (if different from applicant)					
	Estimated cost of development \$900,000				
	Is the property on the Tasmanian Heritage Register?				
(if yes, we recommend you discuss your proposal with Heritage Tasmania prior to lodgement a exemptions may apply which may save you time on your proposal)					

38 Bligh Street, Rosny Park, Tasmania • Address correspondence to: General Manager, PO Box 96, Rosny Park 7018 • Dx: 70402 Telephone (03) 6217 9550 • Email cityplanning@ccc.tas.gov.au • Website www.ccc.tas.gov.au

	If you had pre-application discussions with a Council Officer, please give their name				
	Current Use of Site: Vacand Land				
	Does the proposal involve land administered or owned by the Crown or Council?				
 I have read the Certificate of Title and Schedule of Easements for the land of satisfied that this application is not prevented by any restrictions, easemed covenants. I authorise the provision of a copy of any documents relating to this application any person for the purposes of assessment or public consultation. I again arrange for the permission of the copyright owner of any part of this application be obtained. I have arranged permission for Council's representatives to encland to assess this application I declare that, in accordance with Section 52 of the Land Use Planning Approvals Act 1993, that I have notified the owner of the intention to material application. Where the subject property is owned or controlled by Council Crown, their signed consent is attached. Where the application is submitted Section 43A, the owner's consent is attached. I declare that the information in this declaration is true and correct. 					
Acknowledgement	I acknowledge that the documentation submitted in support of my application will become a public record held by Council and may be reproduced by Council in both electronic and hard copy format in order to facilitate the assessment process; for display purposes during public consultation; and to fulfil its statutory obligations. I further acknowledge that following determination of my application, Council will store documentation relating to my application in electronic format only.				
Applicant's Signature:	28/05/24				

PLEASE REFER TO THE DEVELOPMENT/USE AND SUBDIVISION CHECKLIST ON THE FOLLOWING PAGES TO DETERMINE WHAT DOCUMENTATION MUST BE SUBMITTED WITH YOUR APPLICATION.



RESULT OF SEARCH

RECORDER OF TITLES

Issued Pursuant to the Land Titles Act 1980



SEARCH OF TORRENS TITLE

VOLUME	FOLIO
181251	26
EDITION 2	DATE OF ISSUE 24-Jan-2023

SEARCH DATE : 28-May-2024 SEARCH TIME : 02.46 PM

DESCRIPTION OF LAND

City of CLARENCE

Lot 26 on Sealed Plan 181251

Derivation: Part of 292A-2R-0P Gtd. to William Wallace Fraser

Prior CT 157367/2

SCHEDULE 1

M936604 TRANSFER to THE G.O.A.T (TAS) PTY LTD Registered 24-Jan-2023 at noon

SCHEDULE 2

Reservation	ons and conditions in the Crown Grant if any
SP181251	EASEMENTS in Schedule of Easements
SP181251 (COVENANTS in Schedule of Easements
SP181251	FENCING COVENANT in Schedule of Easements
SP146586	FENCING COVENANT in Schedule of Easements
B300322	PROCLAMATION under Section 9A and 52A of the Roads
ä	and Jetties Act 1935 Registered 22-Sep-1989 at noon
C30987	PROCLAMATION under Section 52A of the Roads and
ı	Jetties Act 1935 Registered 24-Jun-1997 at noon
E329842 I	MORTGAGE to Australia and New Zealand Banking Group
]	Limited Registered 24-Jan-2023 at 12.01 PM

UNREGISTERED DEALINGS AND NOTATIONS

No unregistered dealings or other notations




FOLIO PLAN

RECORDER OF TITLES



Issued Pursuant to the Land Titles Act 1980

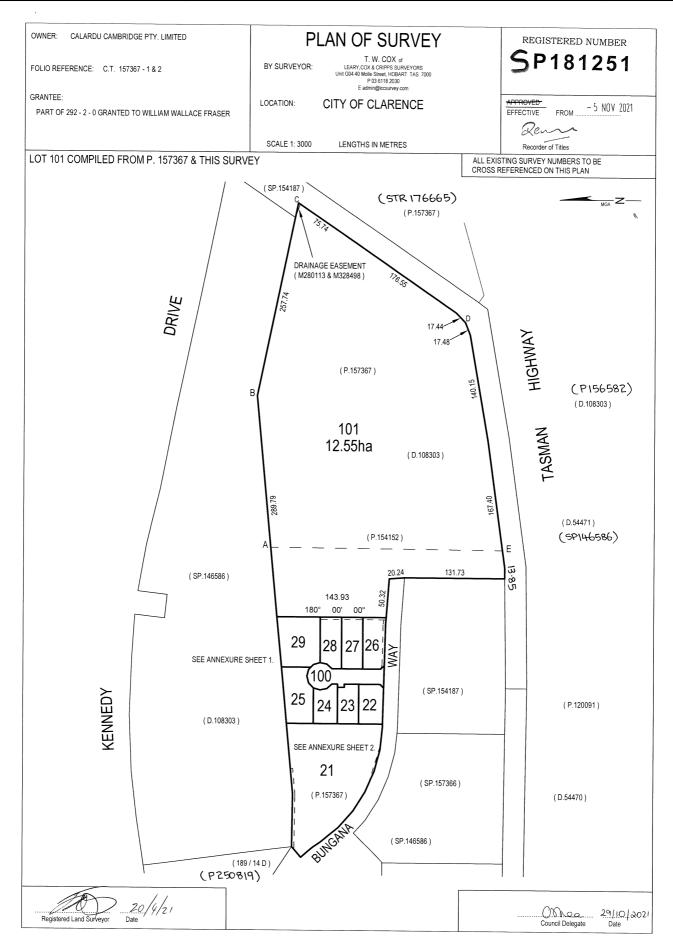

Search Date: 28 May 2024 Search Time: 02:47 PM Volume Number: 181251 Revision Number: 01 Page 1 of 3




FOLIO PLAN

RECORDER OF TITLES



Issued Pursuant to the Land Titles Act 1980

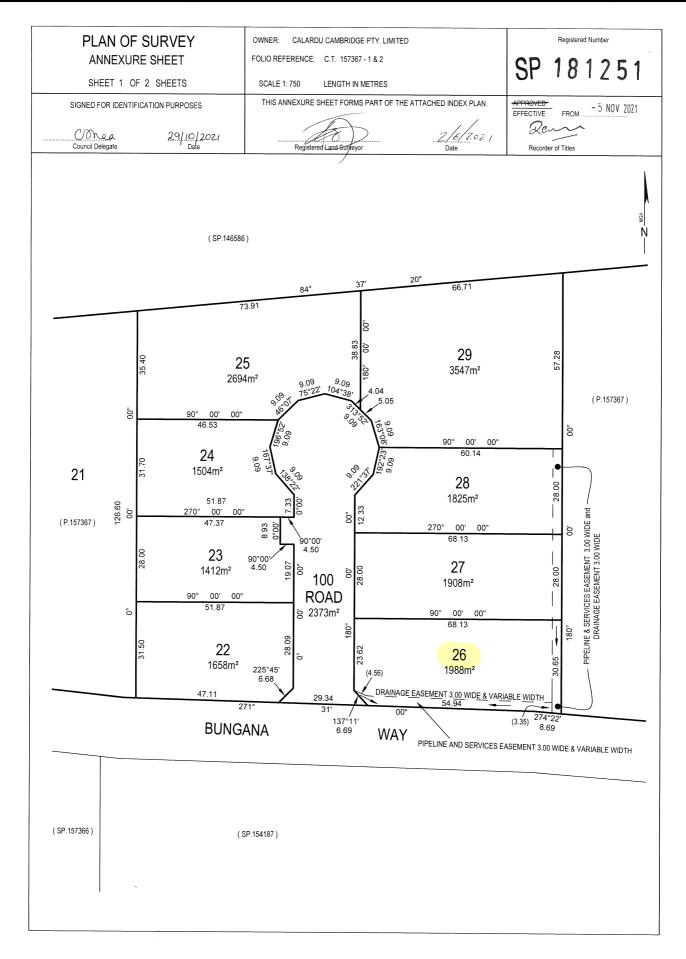

Search Date: 28 May 2024 Search Time: 02:47 PM Volume Number: 181251 Revision Number: 01 Page 2 of 3




FOLIO PLAN

RECORDER OF TITLES



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Search Date: 28 May 2024 Search Time: 02:47 PM Volume Number: 181251 Revision Number: 01 Page 3 of 3

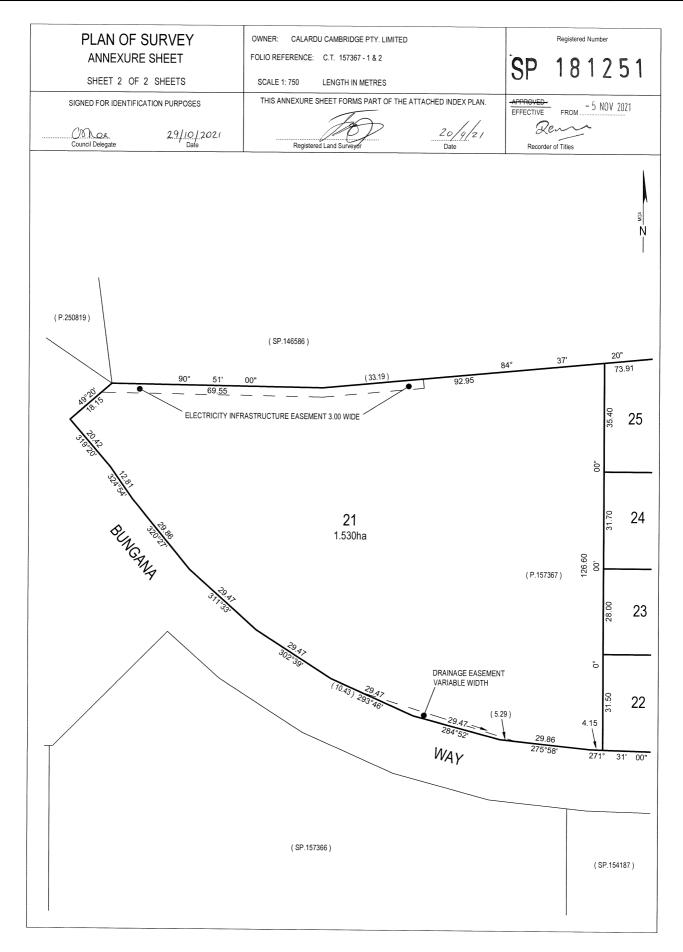Type of construction required C2D2 NCC Vol. I 2022				
Rise in storeys	Class of building 2, 3, 9	Class of building 5, 6, 7, 8		
4 or more 3 2 1	A A B C	A B C C		

Note: The images provided are artistic representations only and should not be used as

2 Lockheed Place, Cambridge

Owner(s) or Clients The G.O.A.T **Building Classification** 5&7 Construction Type C No. of Storeys Jason Nickerson CC6073Y

Designer 762.27m² Total Floor Area Alpine Area N/A

Other Hazards Prone Areas, Airport Noise Exposure

Airport Obstacle Limitation Area, Flood Area (e.g.. High wind, earthquake, flooding, landslip, dispersive soils, sand dunes, mine subsidence,


Title Reference 181251/26

Zoning Particular Purpose - Cambride Commercial

Area 1988m² Land Size Design Wind Speed TBA TBA Soil Classification Climate Zone Corrosion Environment Low Bushfire Attack Level (BAL) N/A

ID	Sheet Name	Issue
A.01	Site Plan	DA-01
A.02	Heavy Vehicle access Access IN	DA-01
A.03	Heavy Vehicle Access OUT	DA-01
A.04	Floor Plan - Lower	DA-01
A.05	Floor Plan - Upper	DA-01
A.06	Elevations	DA-01
A.07	Elevations	DA-01
A.08	Landscaping Plan	DA-01
A.09	Planting Schedule & Details	DA-01

landfill, snow & ice, or other relevant factors)

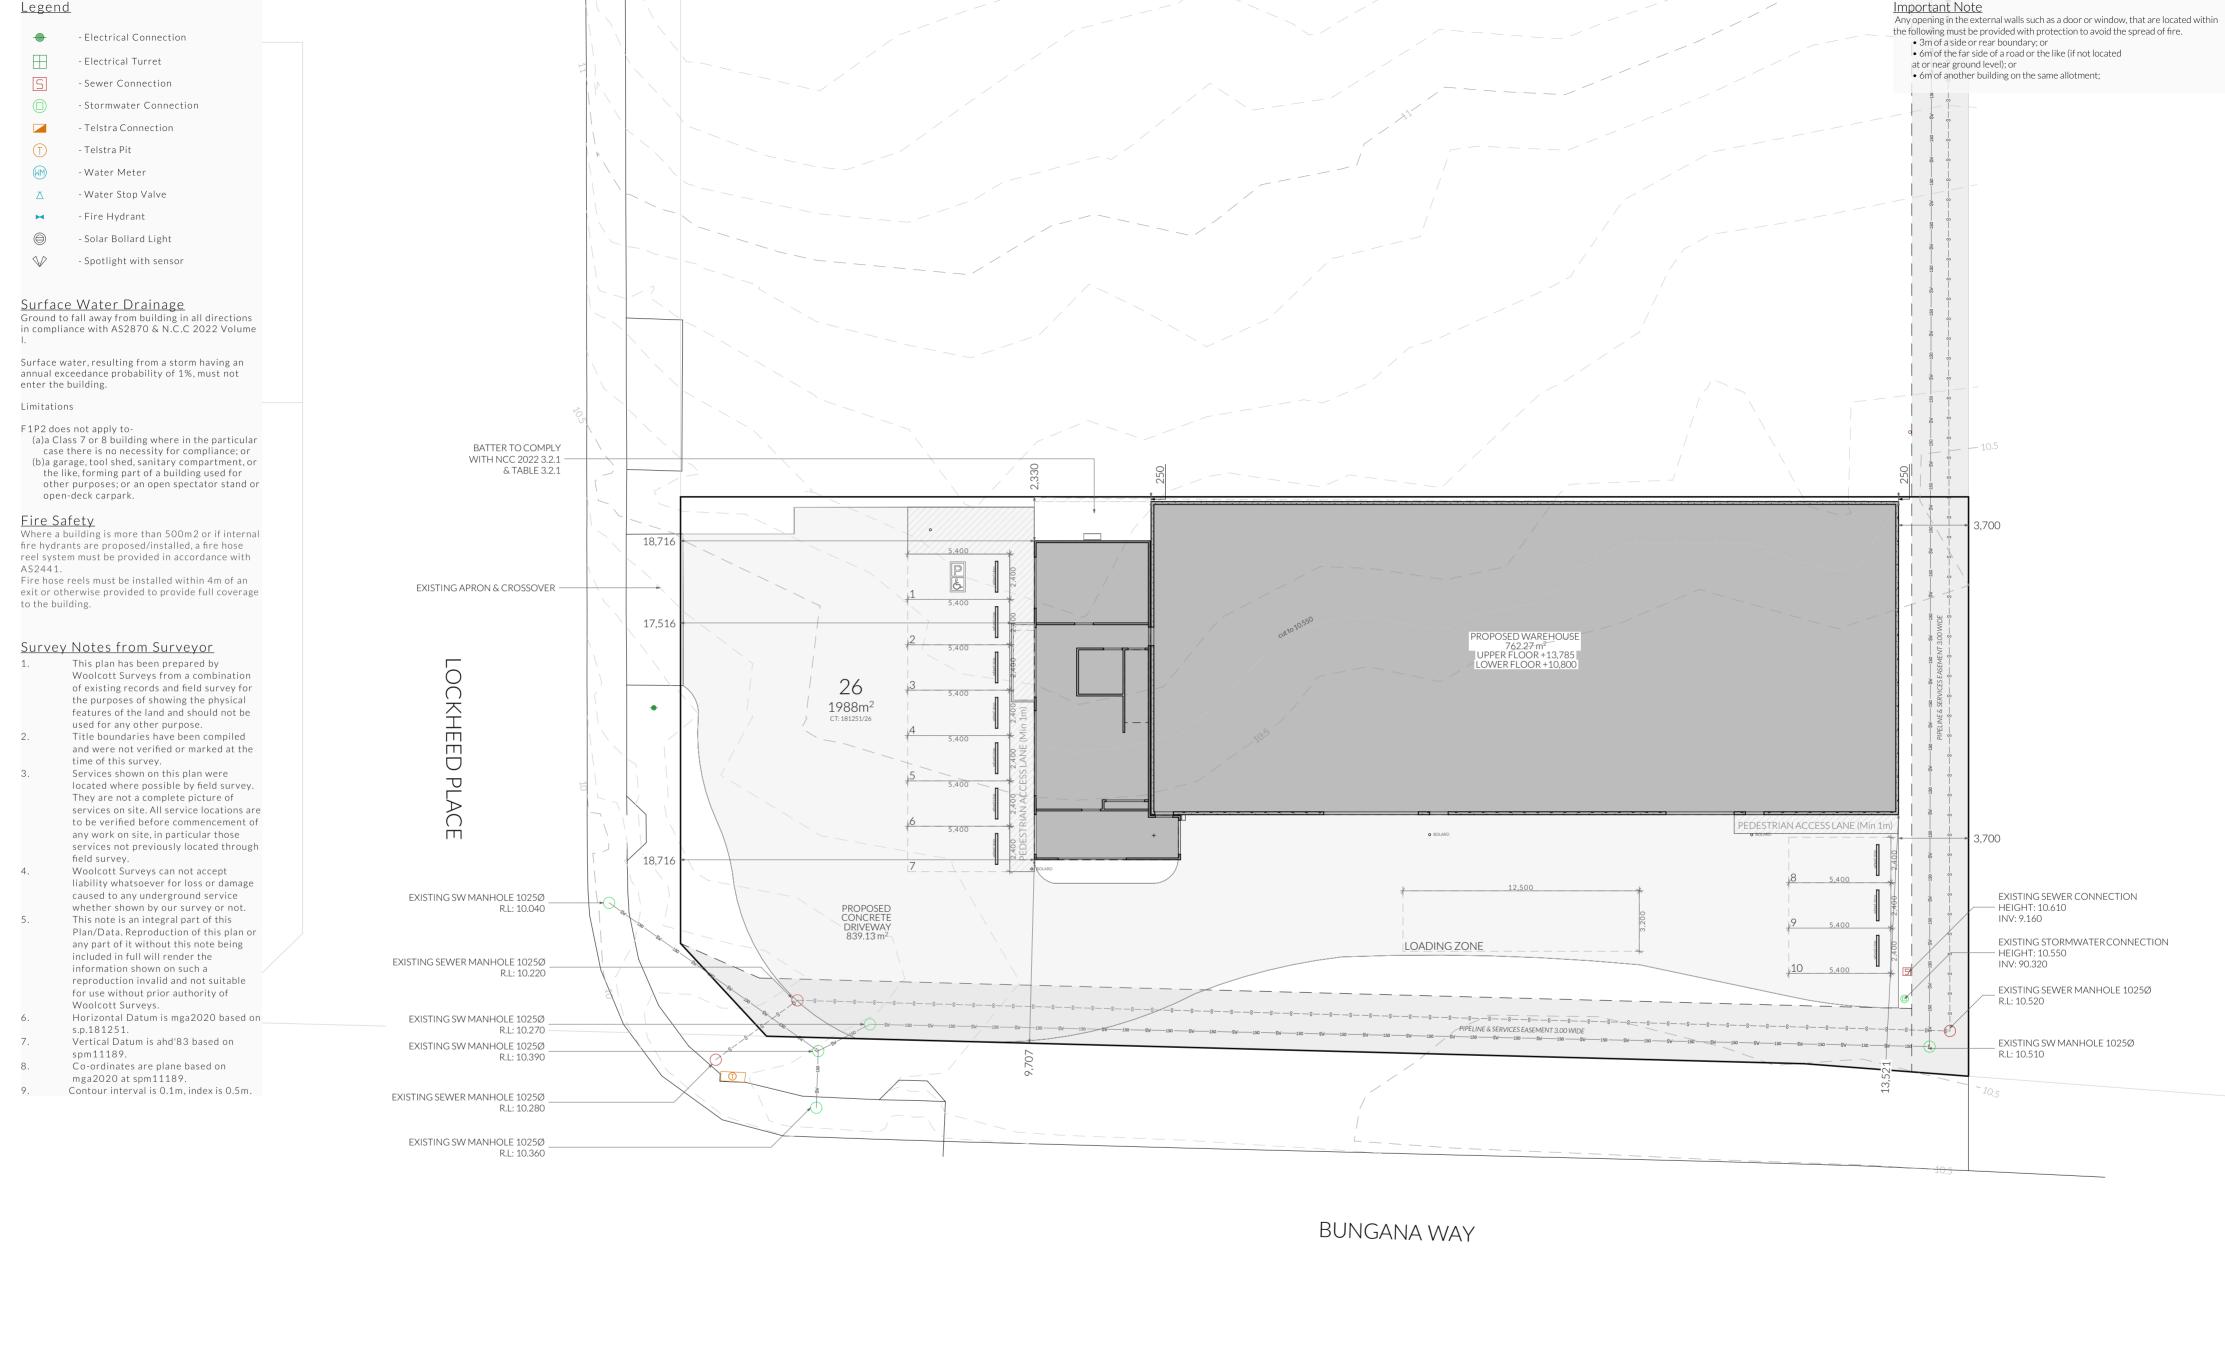

<u>Site Areas</u>

Site Area 1988 m² Building Footprint 726.27m² Driveway Area 942.79 m² Total Impervious Area 83.95%

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Licence: CC6073Y

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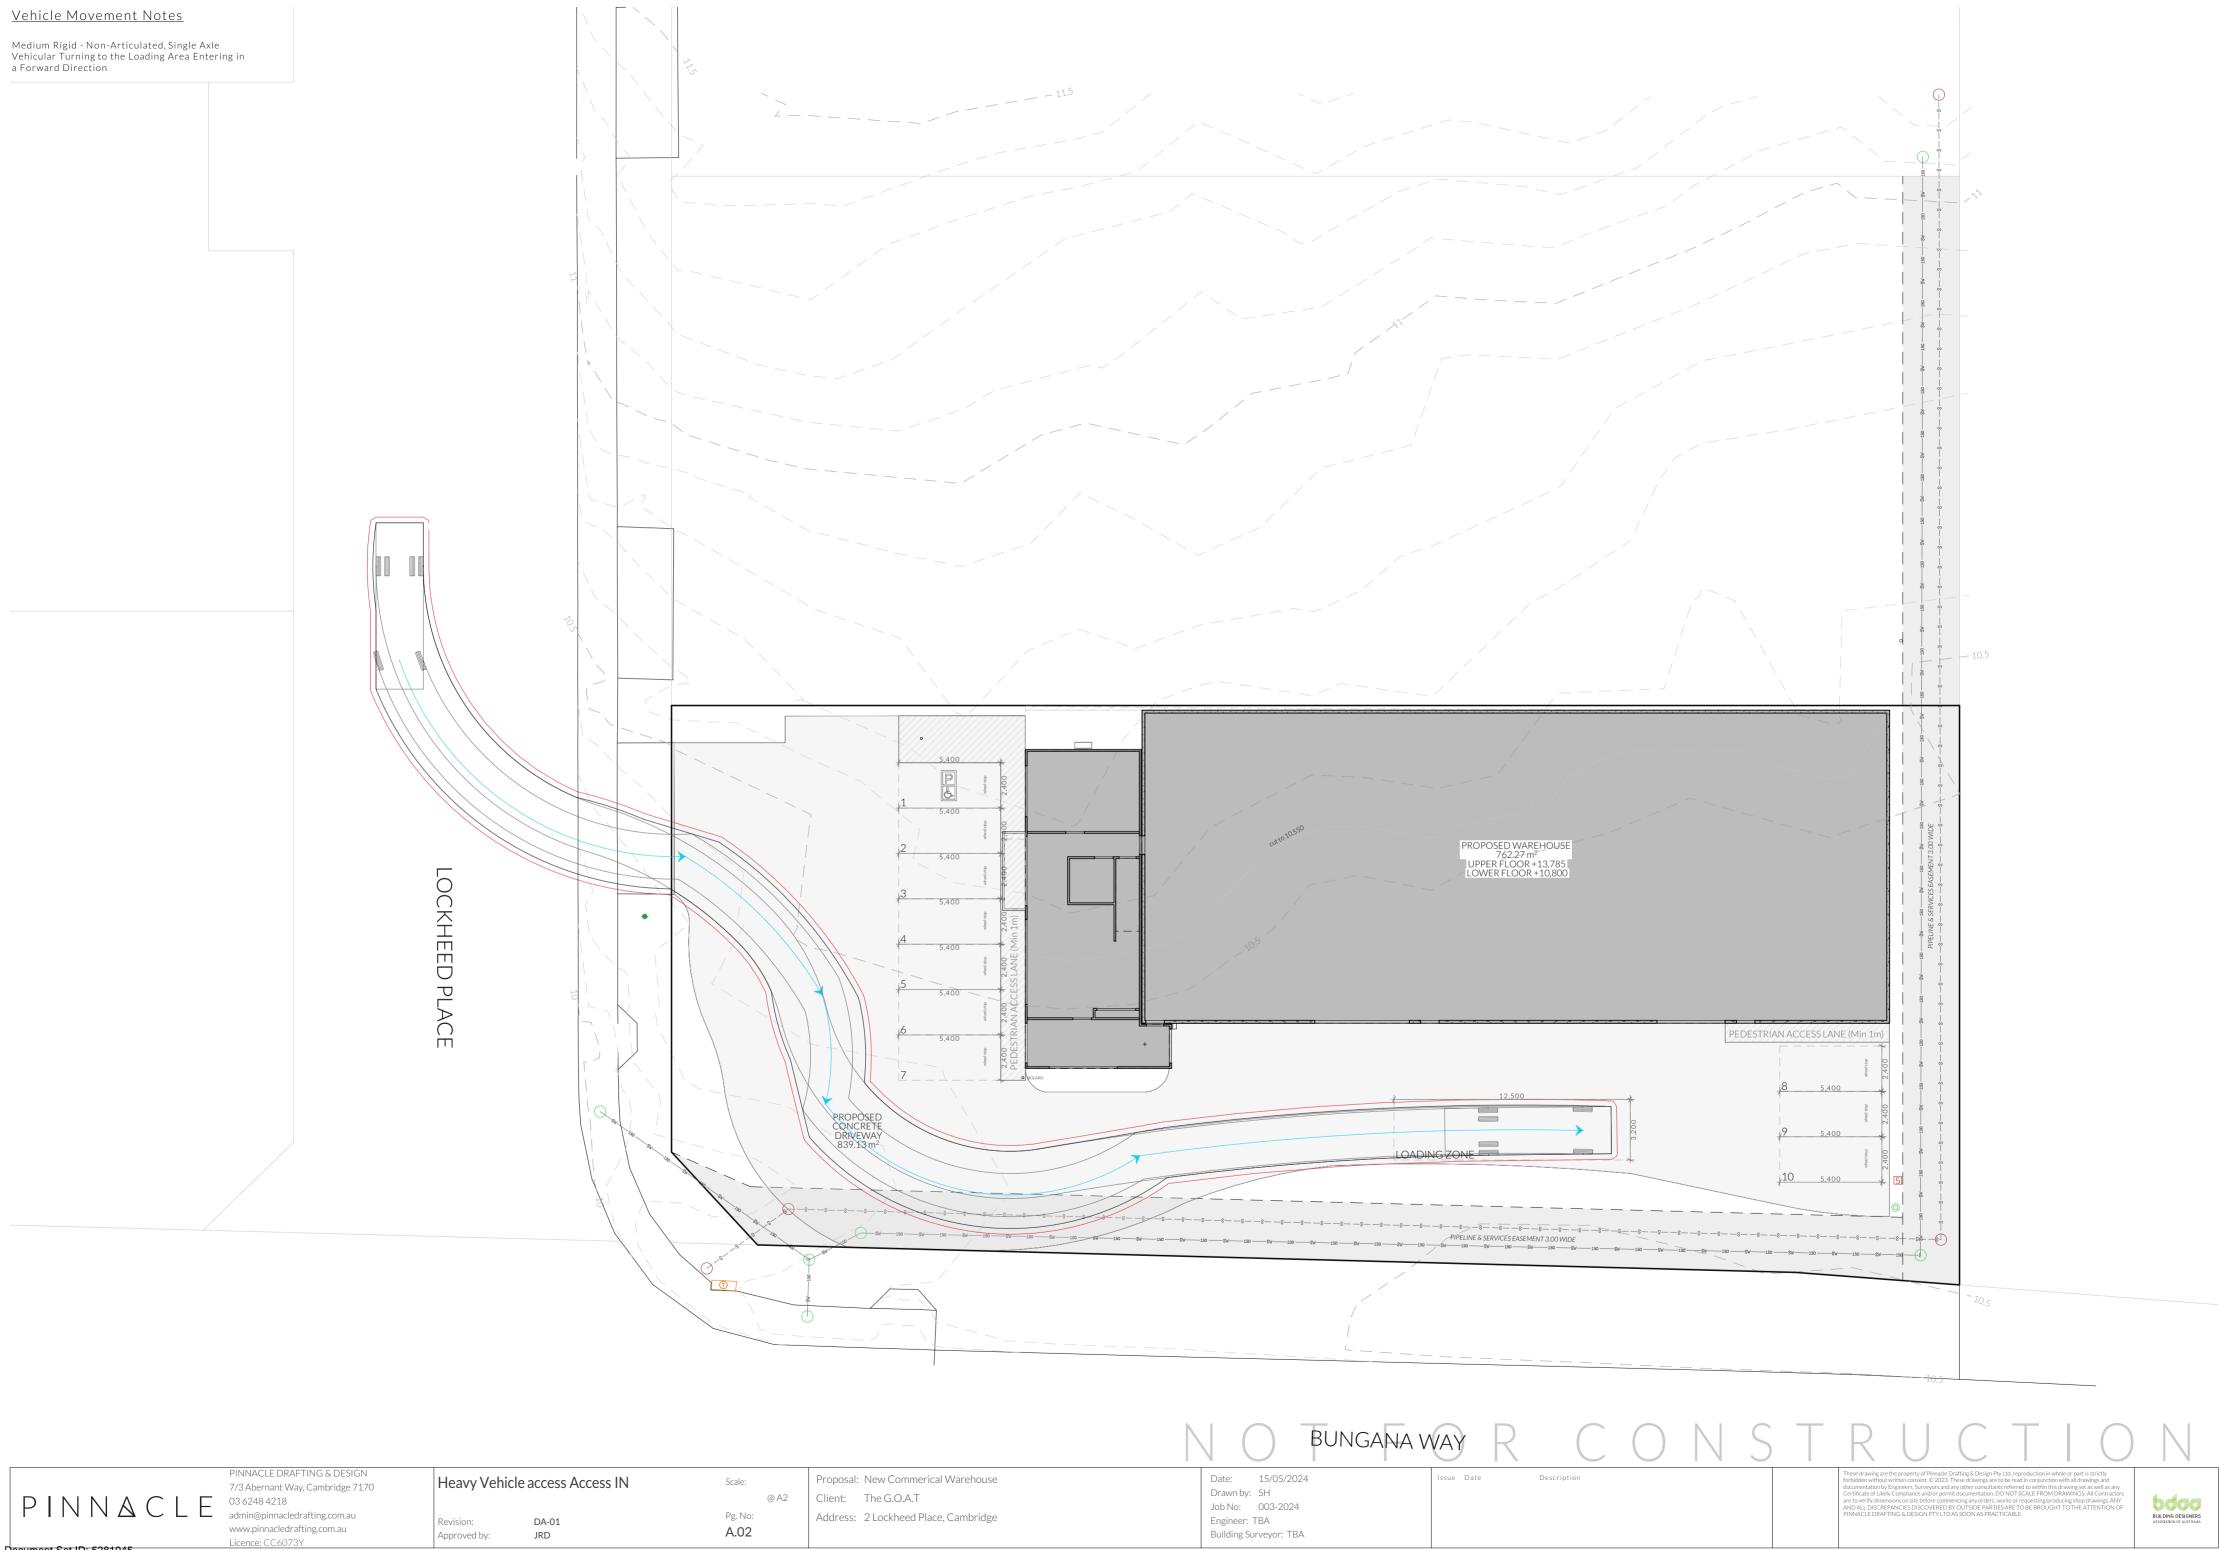
Revision:

Site Plan DA-01 Approved by: JRD


Proposal: New Commerical Warehouse Scale: 1:200 @ A2 Client: The G.O.A.T Pg. No: Address: 2 Lockheed Place, Cambridge A.01

15/05/2024 Drawn by: SH Job No: 003-2024 Engineer: TBA Building Surveyor: TBA







Document Set ID: 5281945 Version: 1, Version Date: 17/06/2024

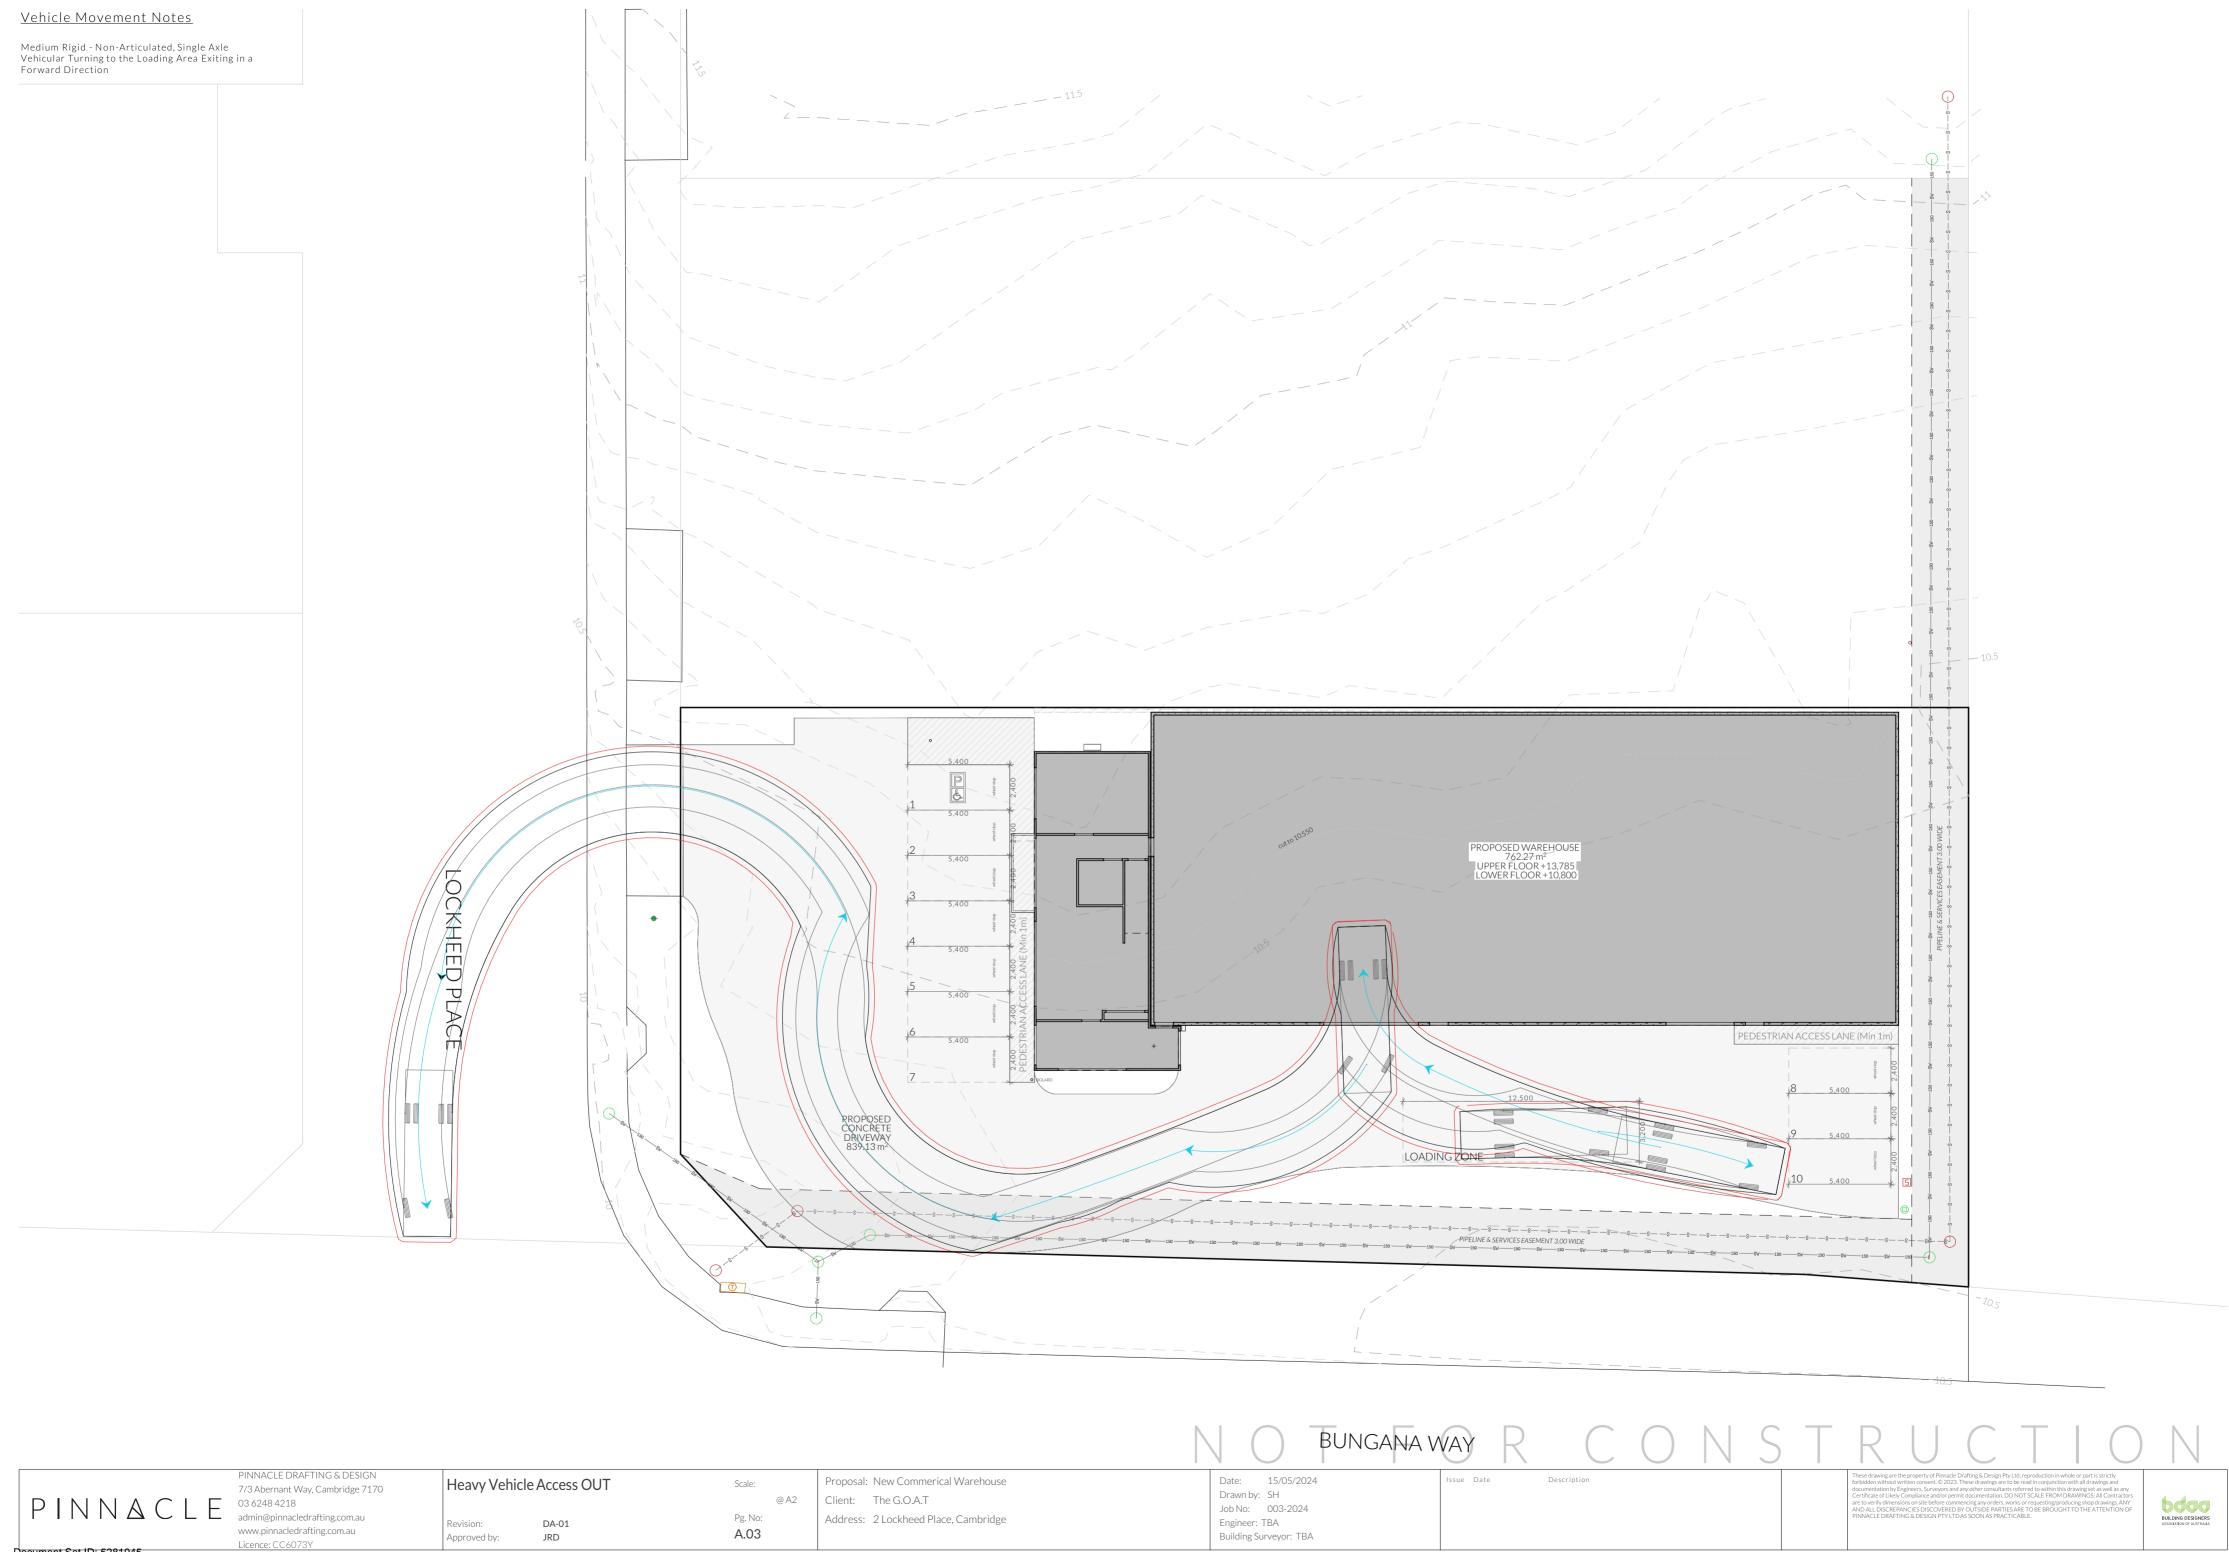


Document Set ID: 5281945 Version: 1, Version Date: 17/06/2024

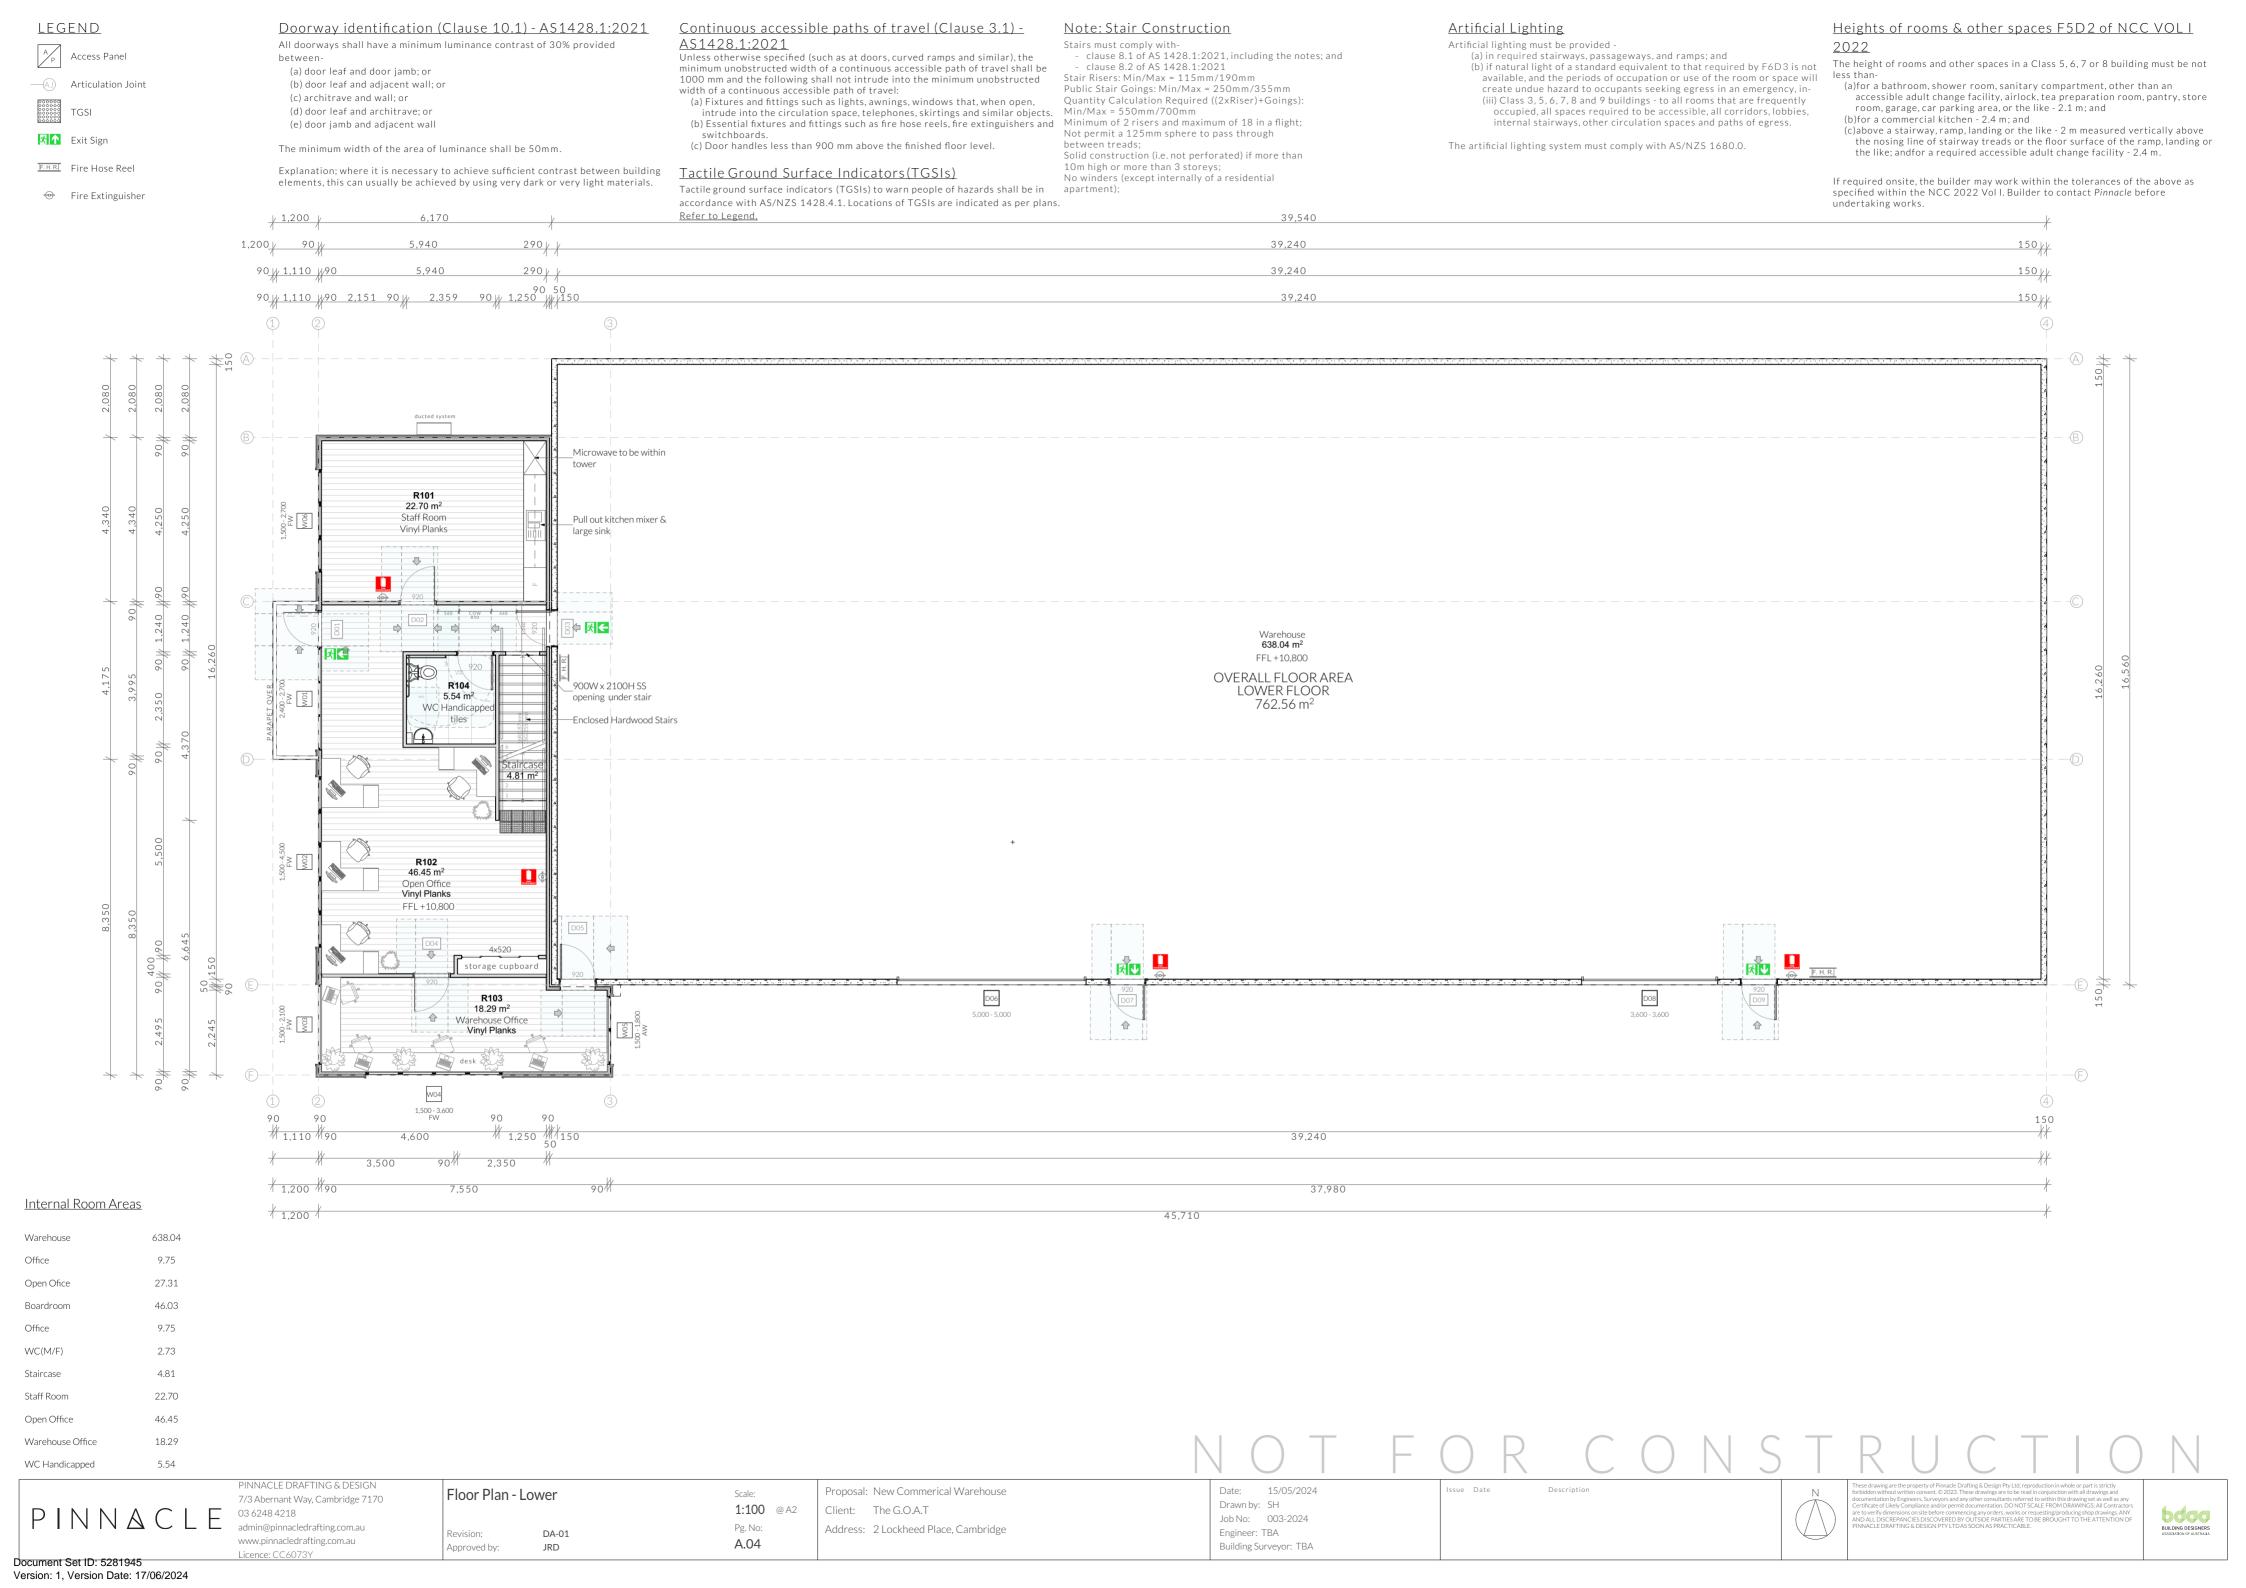

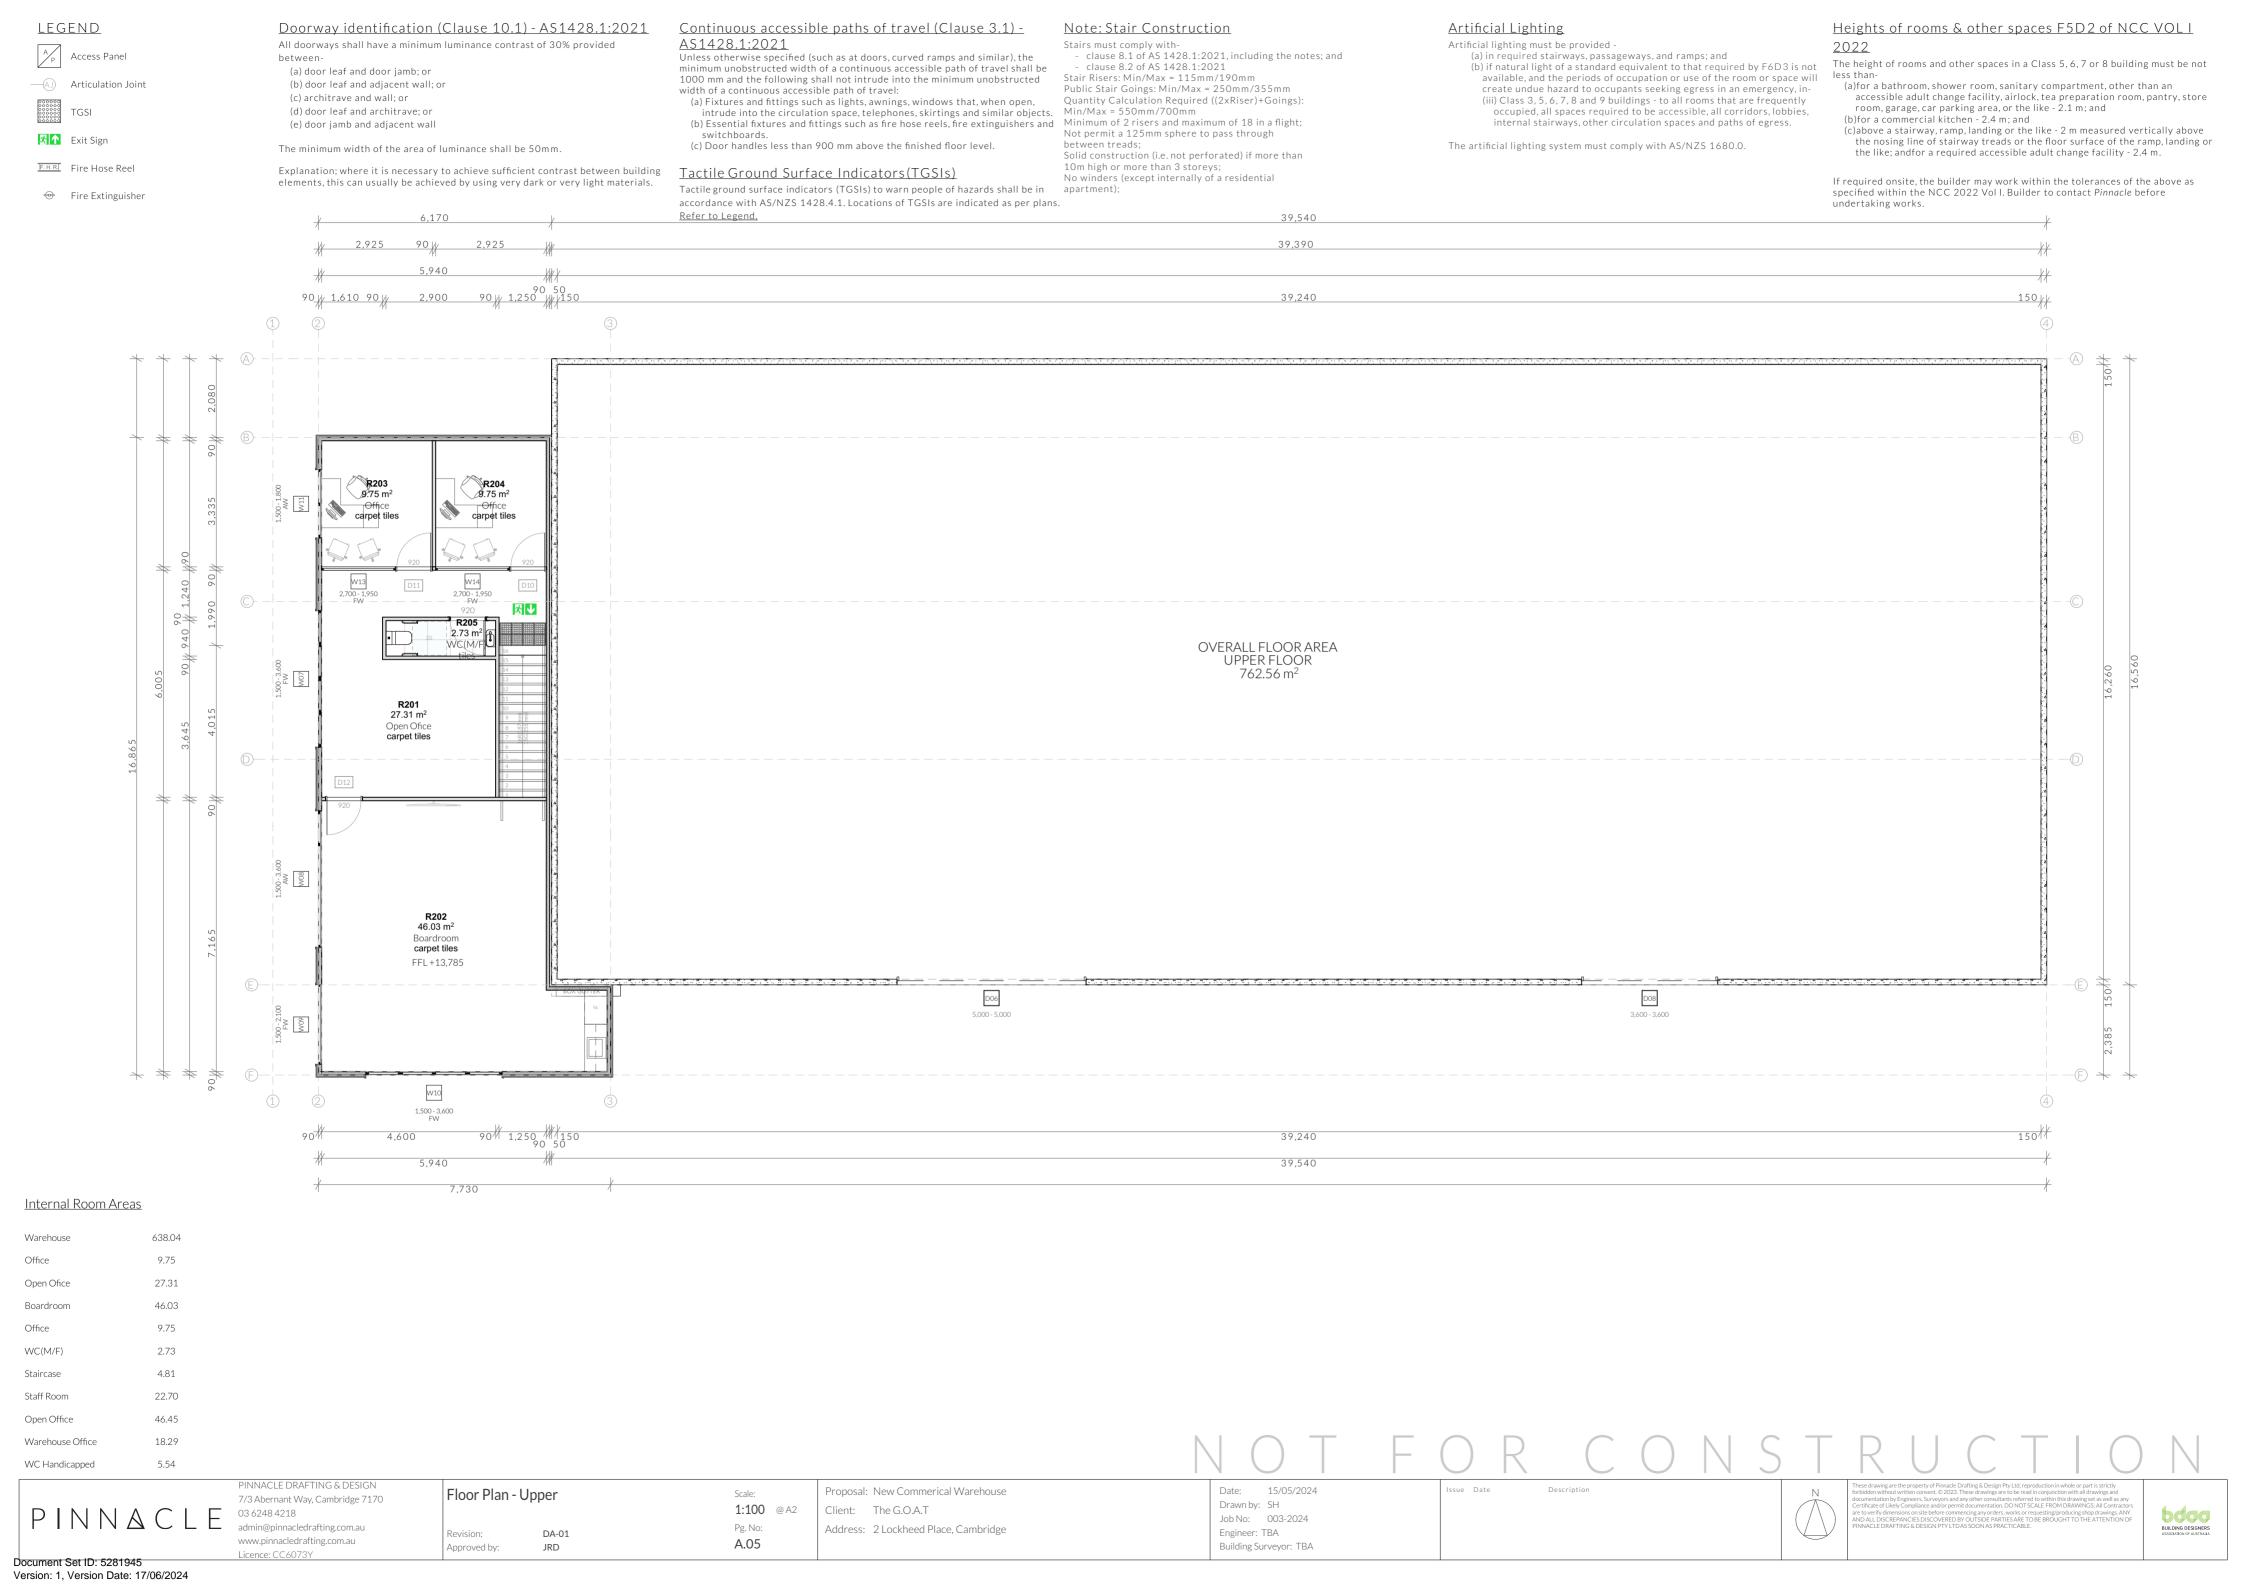



West Elevation 1:100

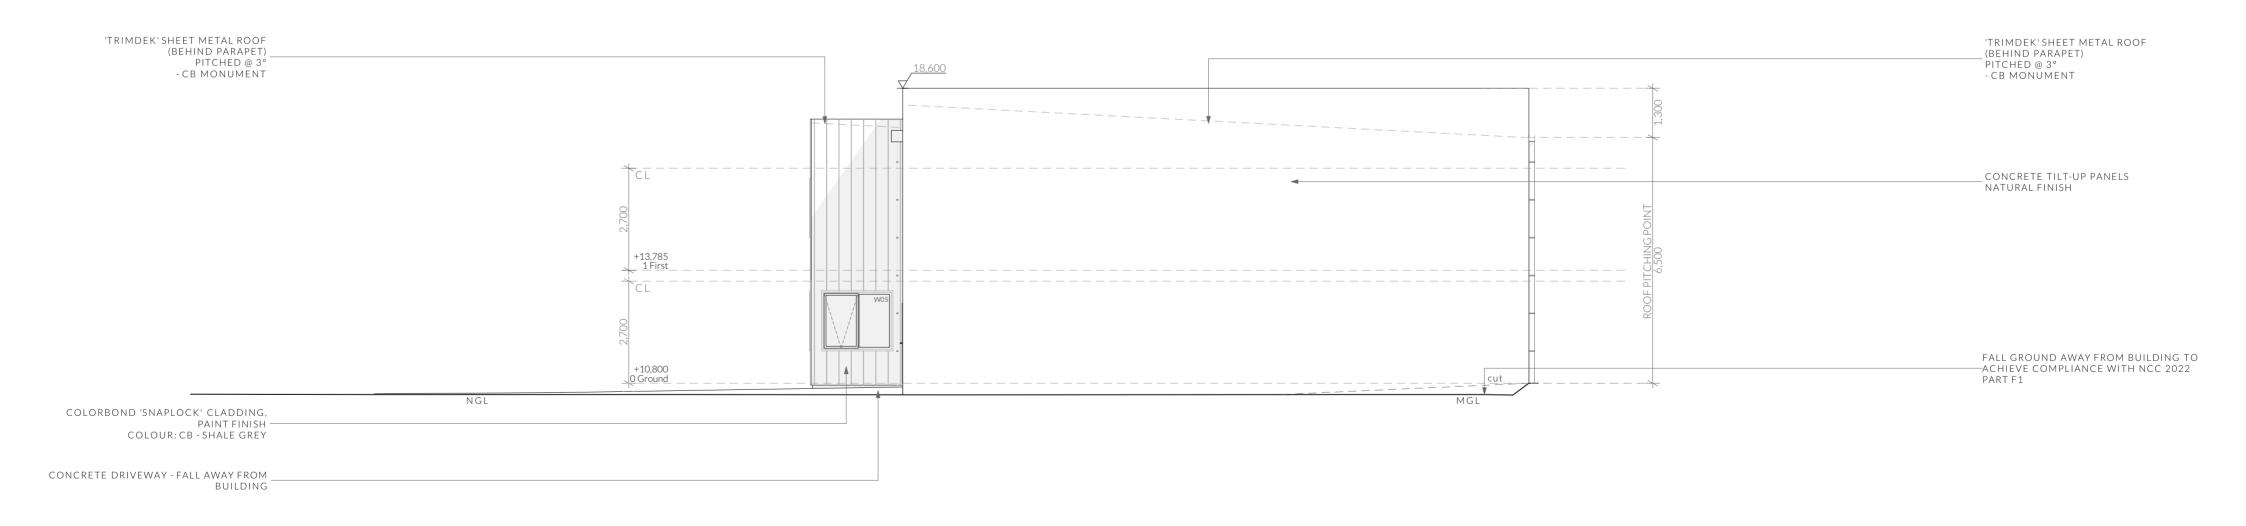

Stairs must comply with clauses 8.1(inclusive of notes) and 8.2 of AS 1428.1:2021.

East Elevation

1:100

A continuous barrier must be provided along the side of the following if the trafficable surface is 1 m or more above the surface beneath.

(a) a roof to which general access is provided; and (b) a stairway or ramp; and

(c) a floor, corridor, hallway, balcony, deck, verandah, mezzanine, access bridge or the like; and

(d) any delineated path of access to a building,

if the trafficable surface is 1 m or more above the surface beneath.

As per NCC Volume I D3D29; Openable windows greater than 4m above ground level are to be fitted with a device to limit the opening or a suitable screen so a 125mm sphere cannot pass through, and withstand a force of 250N and must not have any horizontal or near horizontal elements between 150 mm and 760 mm above the floor that facilitate climbing. Class 7 (Other than carparks) and 8 buildings and parts of those classes must not permit a 300mm sphere to pass through it.

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PINNACLE DRAFTING & DESIGN Elevations 7/3 Abernant Way, Cambridge 7170 03 6248 4218 admin@pinnacledrafting.com.au

Licence: CC6073Y

Revision:


Approved by:

Scale: 1:100 @ A2 Client: The G.O.A.T Pg. No: DA-01 A.06 JRD


Proposal: New Commerical Warehouse Address: 2 Lockheed Place, Cambridge

Date: 15/05/2024 Drawn by: SH Job No: 003-2024 Engineer: TBA Building Surveyor: TBA

BUILDING DESIGNERS ASSOCIATION OF AUSTRALIA

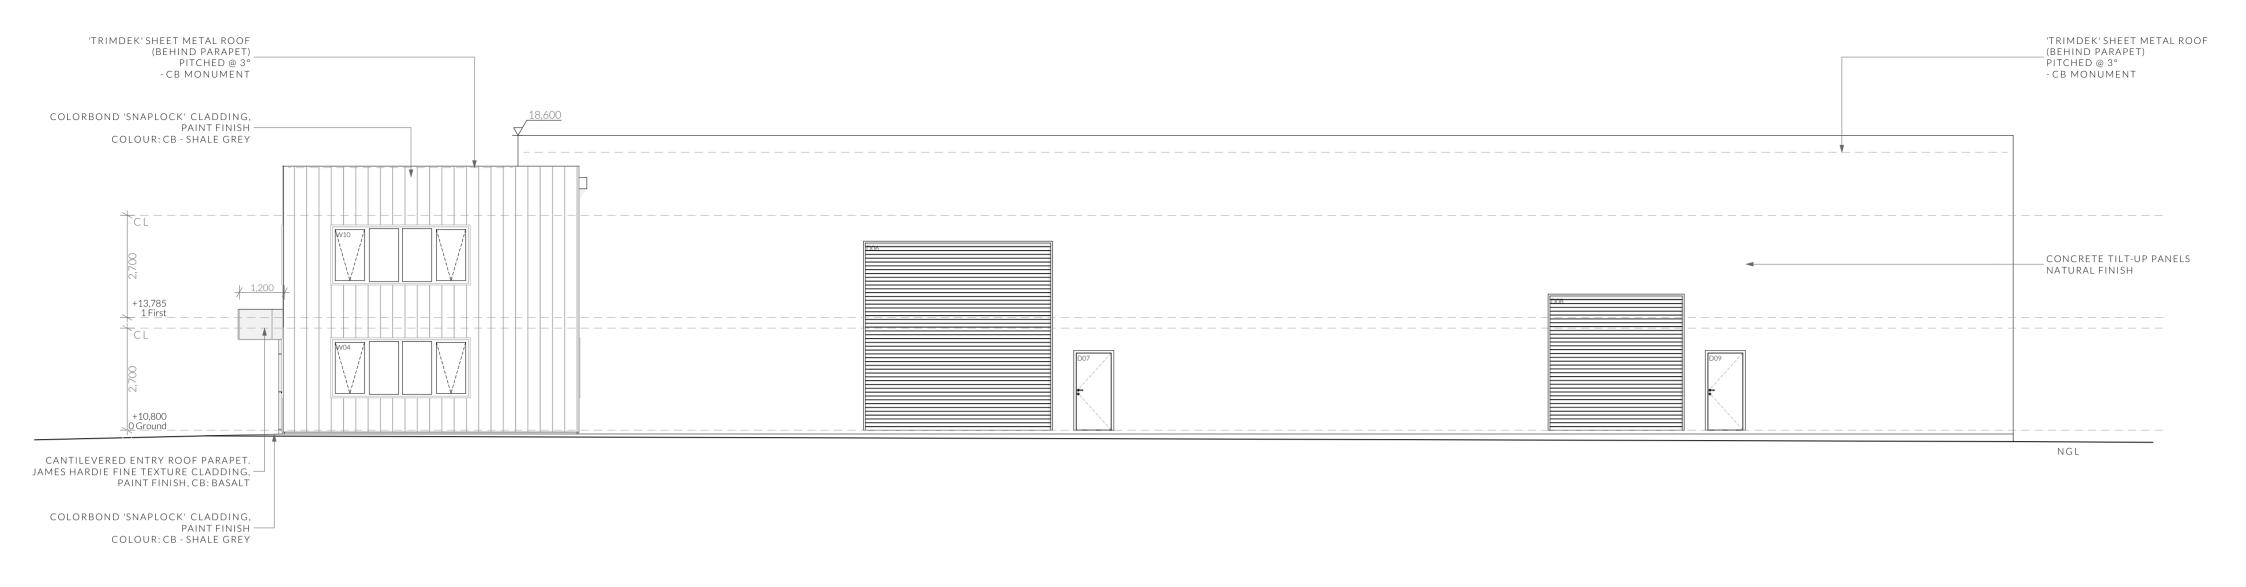

South Elevation

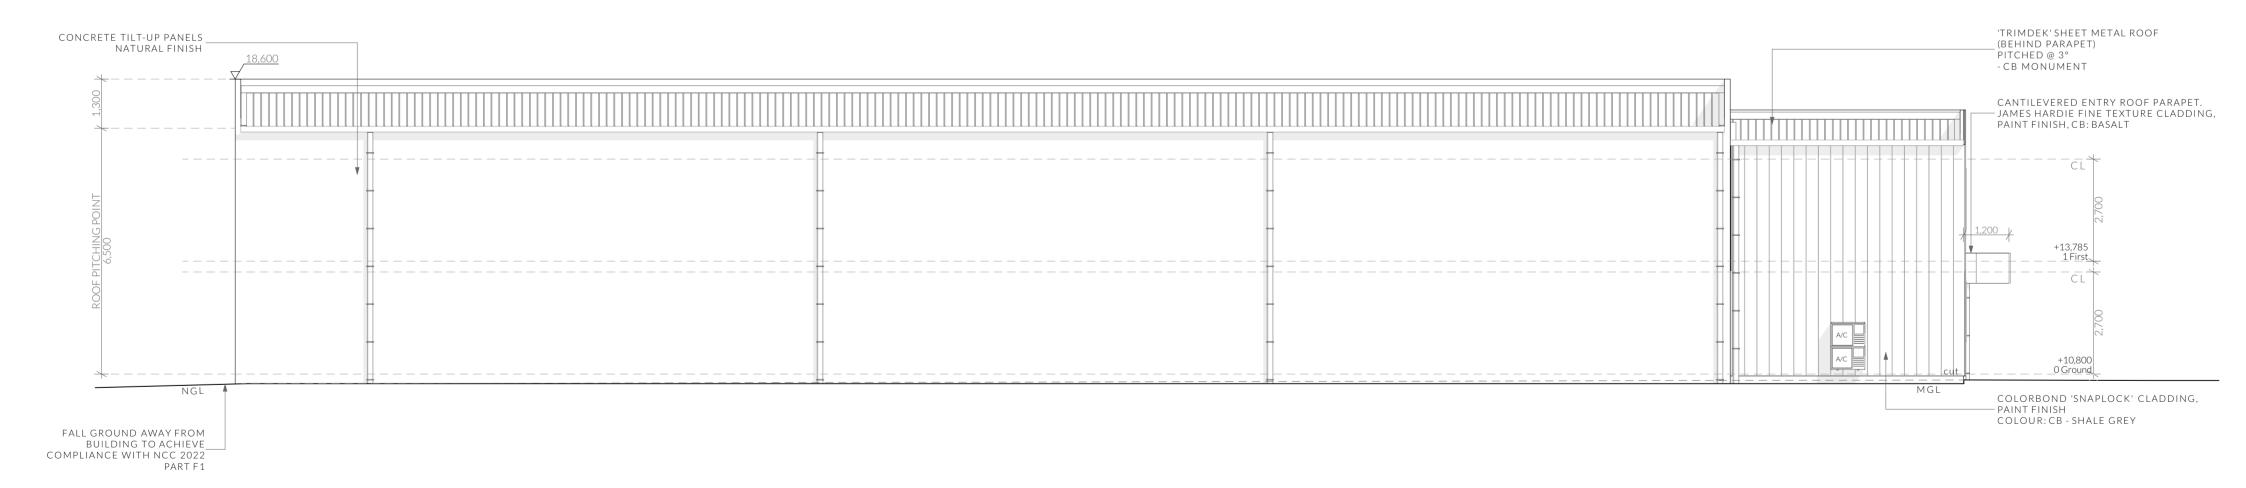

Stairs must comply with clauses 8.1(inclusive of notes) and 8.2 of AS 1428.1:2021.

North Elevation

1:100

1:100

A continuous barrier must be provided along the side of the following if the trafficable surface is 1 m or more above the surface beneath.

Licence: CC6073Y

(a) a roof to which general access is provided; and

(b) a stairway or ramp; and (c)a floor, corridor, hallway, balcony, deck, verandah, mezzanine, access bridge or the like; and

(d) any delineated path of access to a building,

if the trafficable surface is 1 m or more above the surface beneath.

As per NCC Volume I D3D29; Openable windows greater than 4m above ground level are to be fitted with a device to limit the opening or a suitable screen so a 125mm sphere cannot pass through, and withstand a force of 250N and must not have any horizontal or near horizontal elements between 150 mm and 760 mm above the floor that facilitate climbing. Class 7 (Other than carparks) and 8 buildings and parts of those classes must not permit a 300mm sphere to pass through it.


admin@pinnacledrafting.com.au www.pinnacledrafting.com.au

PINNACLE DRAFTING & DESIGN Elevations 7/3 Abernant Way, Cambridge 7170 03 6248 4218

Proposal: New Commerical Warehouse Scale: 1:100 @ A2 Client: The G.O.A.T Pg. No: Address: 2 Lockheed Place, Cambridge DA-01 Revision: A.07 Approved by: JRD

Date: 15/05/2024 Drawn by: SH Job No: 003-2024 Engineer: TBA Building Surveyor: TBA

BUILDING DESIGNERS
ASSOCIATION OF AUSTRALIA

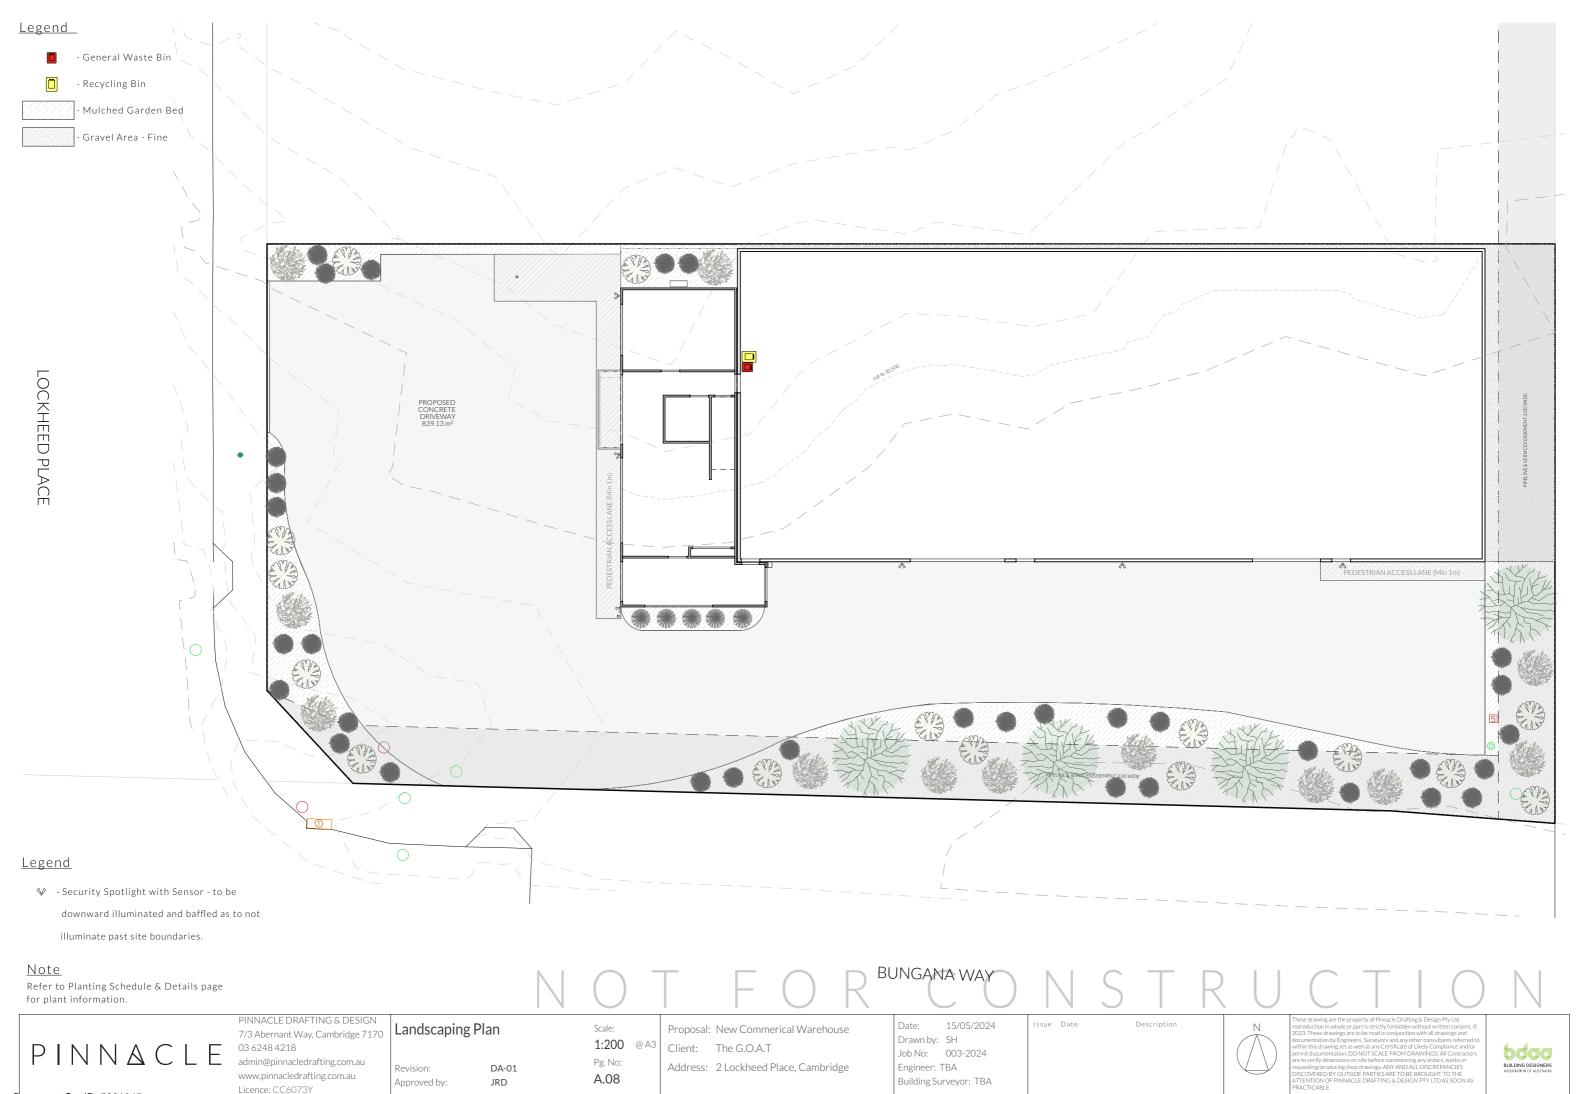


Document Set ID: 5281945 Version: 1, Version Date: 17/06/2024

Planting Schedule

Symbol	Element ID	Qty	Pot Size
	Banksia marginata ' Silver Banksia' or similar - 8m (H) 3-4m (S)	4	300mm
	Correa alba sp. or similar - 1.5m (H) & (S)	15	Tubestock
	Leptospermum lanigerum or similar - 3m (H) 2m (S)	12	140mm
	Lomandra sp. or similar - 1.2-1.5m (H)& (S)	33	Tubestock

Plants have been selected to be drought tolerant and low maintenance once established, it is recommended that a dripper system or similar be put into place until established. Plant locations are indicative and may be altered where suitable growing conditions cannot be met. Garden areas to be mulched with 75mm cover of selected mulch and plants are to fertilised 6 monthly or where required until established. Garden edges are to be timber, steel, or brick. Plantings that are unsuccessful will be replaced where required.

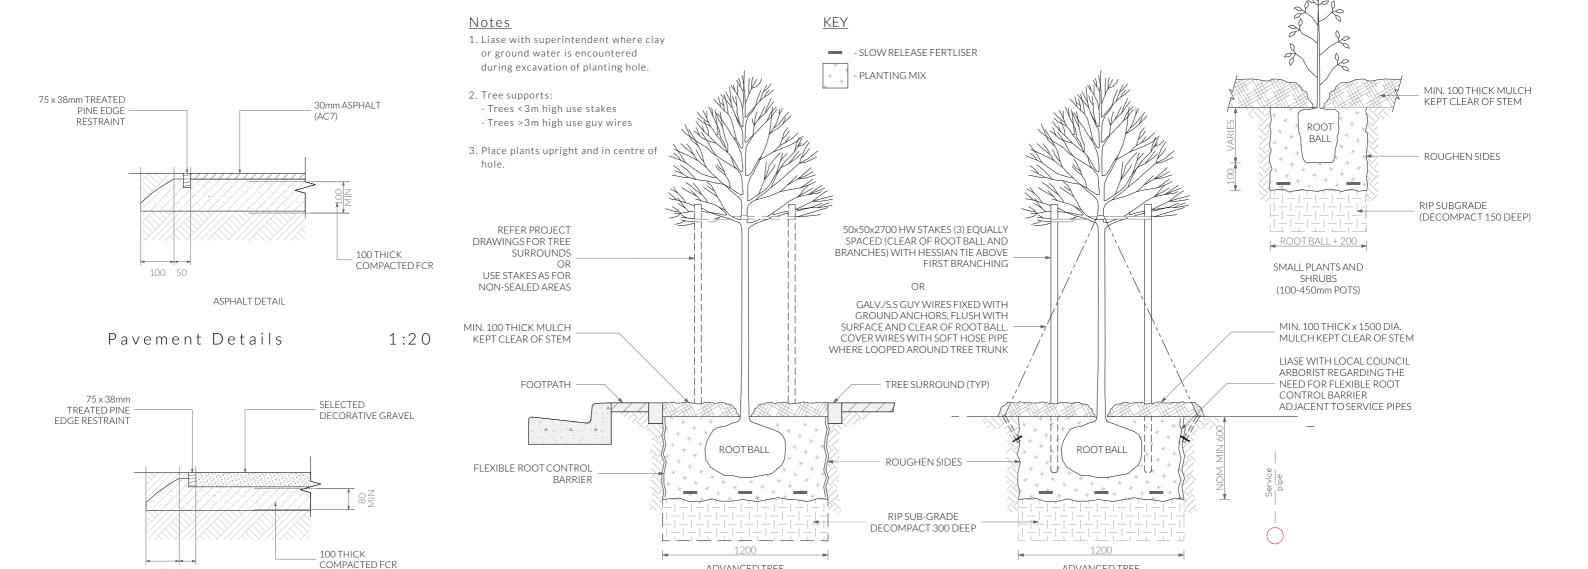

Tree and Shrub Planting

PINNACLE

100 50

Pavement Details

GRAVEL DETAIL

PINNACLE DRAFTING & DESIGN 7/3 Abernant Way, Cambridge 7170 03 6248 4218 admin@pinnacledrafting.com.au www.pinnacledrafting.com.au

Licence: CC6073Y

Planting Schedule & Details

DA-01

1:20

Approved by:

Scale:

Pg. No:

A.09

Proposal: New Commerical Warehouse Client: The G.O.A.T

Address: 2 Lockheed Place, Cambridge

ADVANCED TREE

(SEALED AREAS)

15/05/2024 Drawn by: SH Job No: 003-2024 Engineer: TBA Building Surveyor: TBA

ADVANCED TREE

(NON-SEALED AREAS)



PINNACIF

28/05/2024 Clarence City Council

Dear Sir/Madam.

Planning Application 2 Lockheed Place, Cambridge 7170

Development Overview

The proposed project is for the local company Rapid Clean. The proposed project will be for a new administration building/workshop and storage facility as a direct factory outlet. The lot will mainly be used for storage of materials and equipment for commercial cleaning use and the administration area for operational requirements.

The proposal allows for a concrete access and parking areas, with the remainder to be garden and gravel base.

The exterior of the building utilizes a concrete construction mixed with modern lightweight materials and lighter tones in keeping with the surrounding structures in the area.

The development proposes signage solely for business identification purposes with no illumination or third-party advertising.

Parking has been based on Storage Use requiring a minimum of 10 car parking spaces. The driveway has been designed to accommodate a reverse turning path in, of goods delivery vehicles entering and exiting from Lockheed Place whilst maintaining landscaping for a corner lot.

The following is our supporting written justification against the current planning scheme. Please see our response at the bottom of each code.

CLA P3.0 Particular Purpose

CLA-P3.4 Use Table	
Proposed use class: Storage	
□ No Permit Required☑ Permitted□ Discretionary	

CLA-P3.5 Use Standards

A1

External lighting must: (a) be aligned or baffled to ensure it does not cause direct emission of light onto a carriageway, or impact on the operation of an airport;

Response:
☑ Compliant ☐ Non-compliant ☐ N/A
All external lighting will be for security purposes, being downward illuminated as not to cause nuisance to surrounding properties and carriageways or have impact to the operation of airports in the area.
A2
not operate within the hours of 11.00pm to 6.00am, excluding any security lighting; and
Response:
☑ Compliant ☐ Non-compliant ☐ N/A
Hours of operation will be 8.30am to 4.40pm Monday to Thursday and 8.00am to 4.00pm Fridays. Security lighting will operate outside of these hours on motion sensor activated system.
A3
if for security lighting, be baffled so that direct light does not extend beyond the boundaries of the site.
Response:
☑ Compliant ☐ Non-compliant ☐ N/A
Security lighting will be baffled as well as downward illuminated as not to extend beyond the boundaries of the site.
CLA-P3.5.2 Discretionary use
No Acceptable Solution
Response:
☑ Compliant □ Non-compliant □ N/A

Page **2** of **10**

Development is not a discretionary use.
CLA-P3.6.1 Height A1
Building height must be not more than 15m.
Response:
☑ Compliant □ Non-compliant □ N/A
Maximum building height is 7.8m
CLA-P3.6.2 Setbacks
P1
Buildings may have a setback from a frontage not less than 10m from the Tasman Highway or not less than 6m to any other road, having regard to:
(a) the compatibility of the setback with adjoining buildings, generally maintaining a continuous building line if evident in the streetscape;
(b) the characteristics of the site, adjoining properties and the streetscape;
(c) the parking layout;
 (d) the need to enhance the streetscape, provide adequate space for vehicle access, parking and landscaping and help to attenuate site impacts, taking into account: (i) the site's area and dimensions and the proportion of the intrusion; (ii) compatibility with buildings on adjacent properties in the streetscape; (iii) whether the site is on a corner and whether the discretion relates to only one frontage; Tasmanian Planning Scheme - Clarence LPS (iv) whether the intrusion is for a minor component of the building that enhances the appearance of the site; and (v) the adequacy of land retained for landscaping to enhance the appearance of the site and for appropriate vehicular access; and
(e) the local area objectives.
Response:
☑ Compliant ☐ Non-compliant ☐ N/A
(a) The adjacent warehouse at 4 Lockheed has a primary frontage setback of 18.61m whilst the proposed development at 2 Lockheed has a setback from the same

Page **3** of **10**

- primary frontage of 18.17m which is consistent along Lockheed Place. There is currently no pattern of development along Bungana Way visible.
- (b) The characteristics of the site have dictated the proposed structure be located 250mm from the northern boundary in an attempt to meet the frontage setbacks of the acceptable solution and accommodate other requirements such as landscaping and reverse -entry and forward exit medium rigid turning for operational requirements. There is currently no pattern of development along Bungana Way visible and the shortest setback on the secondary frontage is over 6m at 9,707.
- (c) The siting of the structure is to accommodate alternative landscaping and reverse entry and forward exit medium rigid vehicular turning to the loading area along Bungana Way.
- (d) (i) The proportion of the intrusion from the acceptable solution is 293mm on the shortest boundary setback and acceptable of the 6m setback stated as discretionary.
 - (ii) There is currently no pattern of development along Bungana Way visible.
 - (iii) The site is a corner site and the discretion of 293mm is only along one side of the secondary frontage along Bungana Way.
 - (iv) The intrusion is to accommodate other requirements such as landscaping and reverse -entry and forward exit medium rigid turning for operational requirements.
 - (v) The landscaping has been laid out to accommodate reverse -entry and forward exit medium rigid vehicular turning to the loading area along Bungana Way, whilst attempting to enhance the appearance of the site and accommodate as much landscaping as practically possible.
- (e) The site has been designed with the local area objectives in mind helping to provide a range of uses, that the landscaping is in keeping with surrounding development as much as practically possible, by aiding in the attractive built character of the zone and the treatments and landscaping influenced by the surrounding valley landscape setting of forested and rural hills. The undulation of the driveway design not only accommodates turning requirements but is complimentary to this.

P2

Buildings must be sited a sufficient distance from side and rear boundaries to enhance the streetscape, provide adequate space for vehicle access, parking, maintenance access and landscaping and help to attenuate site impacts, having regard to:

- (a) the site's area and dimensions and the proportionate intrusion;
- (b) compatibility with buildings on adjacent properties in the streetscape;
- (c) compatibility with setback on the adjoining property and whether the reduction would leave inadequate space between the buildings for a landscaped buffer to enhance the appearance of the area;

(d)	the setback on the opposite side of the site and whether the reduction will be offset by landscaping on that side; and
(e)	whether the proposed height of the building and length of the proposed setback from side and rear boundaries will cause an unreasonable loss of amenity to the adjoining property including unreasonable overshadowing of any area required for a landscaping treatment.
Respo	nse:
	⊠ Compliant □ Non-compliant □ N/A
(a)	The side setback intrusions are to accommodate requirements such as landscaping and reverse -entry and forward exit medium rigid turning for operational requirements. The site's area and usage are proportionate to the intrusion. There is no rear setback for the lot by definition.
(b)	The adjacent warehouse at 4 Lockheed has side setbacks of 1420 on the North Boundary and 3712 on the Eastern Boundary. The proposal for 2 Lockheed Place has a setback of 250mm to accommodate requirements such as landscaping and reverse -entry and forward exit medium rigid turning for operational requirements as this lot is restricted by two frontage setbacks being a corner lot. The Eastern setback (although dictated by an easement) remains compatible with 4 Lockheed Place at 3700. There is currently no pattern of development along Bungana Way visible.
(c)	The landscaping of the proposal undulates leaving large pockets of more easily maintained landscaping than one large strip. The proximity of the structure and intrusion on the northern side boundary allows for adequate reverse -entry and forward exit medium rigid turning and to maximise landscaping at the primary and secondary frontages.
(d)	The Setbacks on the opposing sides of the side setbacks (the frontage setbacks) are designed to accommodate as much landscaping as possible whilst working to provide adequate reverse -entry and forward exit medium rigid turning for operational requirements.
(e)	The encroachment on the Northern Boundary setback will not unreasonably affect the site of 4 Lockheed Place in loss of amenity nor will it overshadow the site in any way, as 4 Lockheed Place is sited directly North of the proposal of 2 Lockheed Way.

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Р1

The design of buildings must enhance the appearance of the site and the streetscape having regard to

Therefore, overshadowing will not be a concern.

(a) making a positive contribution to the character of the area, by promoting an attractive image, especially for building elements that face the Tasman Highway;		
(b) the need for buildings to:		
(i) use external cladding with suitable tone, texture, materials, relief and fenestration;		
(ii) not present blank facades to the street or to customer car parking areas;		
(iii) ensure walls fronting the Tasman Highway and any internal car park contain sufficient glazing, to ensure the premises interacts positively with the pedestrian environment and enhances the gateway entrance to Hobart;		
(c) whether ancillary shops, offices, cafes, or other facilities are integrated with the design of buildings containing the principal use;		
(d) the minimisation of visual intrusiveness of roof-top service infrastructure, including service plants and lift structures by integrating them into the building design;		
(e) wind protection for the convenience, comfort and safety of pedestrians;		
(f) the local area objectives; and		
(g) an urban design context report.		
☑ Compliant☐ Non-compliant☐ N/A		
(a) The proposed design contributes to the character or the area in a positive way by promoting an attractive corner façade. Building elements are concealed from the Tasman highway by No. 89 Cambridge Park Drive.		
(b) (i) The proposal utilises light muted tones in keeping with that of 4 Lockheed Way as well as similar cladding and façade door and window relief and fenestration as practically as possible for a corner lot.		
(c) The lot does not front the Tasman Highway.		
(d) The proposed project will be for a new administration building/workshop and storage facility as a direct factory outlet. The lot will mainly be used for storage of materials and equipment for commercial cleaning use and the administration area for operational requirements. No roof top servicing is proposed. AC external services are located on the plans and are indicated to the north side of the administration part of the complex.		
(e) The proposal provides wind protection for the convenience, comfort and safety of pedestrians with shielding coming predominantly from surrounding structures namely 89 Cambridge Park Drive as it's sheer bulk and scale will provide cover for 2 Lockheed Place from the SW prevailing winds.		

- (f) The site has been designed with the local area objectives in mind helping to provide a range of uses, that the landscaping is in keeping with surrounding development as much as practically possible, by aiding in the attractive built character of the zone and the treatments and landscaping influenced by the surrounding valley landscape setting of forested and rural hills. The undulation of the driveway design not only accommodates turning requirements but is complimentary to this.
- (g) Not Applicable

CLA-P3.6.4 Passive surveillance

P1

Building design must provide for passive surveillance of public spaces, having regard to:

- (a) providing the main entrance or entrances to a building that are clearly visible from nearby buildings and public spaces;
- (b) locating windows to adequately overlook the street and adjoining public spaces;
- (c) incorporating shop front windows and doors for ground floor shops and offices, so that pedestrians can see into the building and vice versa;
- (d) locating external lighting to illuminate any entrapment spaces around the building site;
- (e) providing external lighting to illuminate car parking areas and pathways;
- (f) the need for public access to provide high visibility for users and provide clear sight lines between the entrance and adjacent properties and public spaces; and
- (g) the need to provide for sight lines to other buildings and public spaces

Response:

\boxtimes	Compliant
	Non-compliant
	N/A

- (a) The main entrance is located on the primary frontage clearly visible from both Lockheed Place and Bungana Way and accessible from the existing crossover from Lockheed Place.
- (b) Windows have been located on both street frontages of the administration building to overlook both Lockheed Place and Bungana Way.
- (c) Sizeable windows have been proposed for both frontages to the ground floor administration building overlooking both Lockheed Place and Bungana Way so that pedestrians can see into the building and vice versa.
- (d) No entrapment spaces are present on the proposal.

- (e) Security lighting will be provided illumination to external car parking spaces and transfer spaces for vehicles on a sensor system.
- (f) There are no adjacent public spaces or accesses to adjacent sites relevant to the proposal.
- (g) Sight lines are adequate to other buildings in the area with the discretionary frontage setbacks being compliant. There are no adjacent public spaces relevant to the proposal.

CLA-P3.6.5 Landscaping

P1

Landscaping must enhance the appearance of the site and the streetscape, having regard to:

- (a) the appearance and amenity of the development, including any public car parking area;
- (b) the need to recognise the importance of the appearance of Tasman Highway as the gateway entrance to Hobart, by providing landscaped buffers to enhance buildings and sites abutting the Highway;
- (c) the ability to provide a range of plant height and forms to create diversity, interest and amenity;
- (d) using landscaping to soften the visual impact of buildings by breaking up building mass and enhancing architectural elements;
- (e) the area within 10m of a boundary abutting the Tasman Highway, or 6m to any other road, excluding site entry or exit access, must be landscaped; and (f) the local area objectives.

Response:

- ☑ Compliant☑ Non-compliant
- □ N/A
- (a) The proposal includes landscaping that enhances the appearance of the site, public car parking areas and amenity of the development with an undulating design creating interest and easily maintained pockets of landscaped areas.
- (b) The site does not abut the Tasman Highway.
- (c) The proposal includes 4 different varieties of plant species all providing a range of height and forms to create diversity, interest and amenity.
- (d) The undulating landscaping design helps to soften the visual impact of the building by breaking up the impervious areas and the range of height and species adds to the interest of the landscape design.
- (e) The 6m landscaped area has not been able to be adhered to due to the corner lot and operation requirements of the development. Due to the need to provide reverse -

entry and forward exit medium rigid vehicular turning to the loading area along Bungana Way the deepest landscaped area is 5,256mm from the secondary frontage. Due to the nature of the corner lot, and requirement for vehicular access, the maximum landscaping has been provided wherever possible. The design accommodates larger pockets of landscaping, making for easier maintaining of vegetation and adding interest to the proposal.

(f) The site has been designed with the local area objectives in mind, promoting the use of bulky goods sales, helping to provide a range of uses, that the landscaping is in keeping with surrounding development as much as practically possible, by aiding in the attractive built character of the zone and the treatments and landscaping influenced by the surrounding valley landscape setting of forested and rural hills. The undulation of the driveway design not only accommodates turning requirements but is complimentary to this.

CLA-P3.6.6 Outdoor storage and display		
A1		
Outdoor storage areas, excluding for the display of goods for sale, must:		
(a) be located behind the façade of the building; and		
(b) have all stored goods and materials screened from public view.		
Response:		
☑ Compliant ☐ Non-compliant ☐ N/A		
(a) All goods will be stored in the warehouse behind the façade of the building.		
(b) All goods will be stored in the warehouse behind the façade of the building and screened from public view.		

CLA-P3.6.7 Fencing

A1

Fencing must comply with the following:

- (a) fences, walls and gates 1.5m above existing ground level must not be erected within 10m of a frontage;
- (b) frontage fences must be at least 50% transparent above a height of 1.2m.

Response:	
☑ Compliant ☐ Non-compliant ☐ N/A	
(a) Not applicable. No fencing is proposed on the subject site.	
(b) Not applicable. No fencing is proposed on the subject site.	

I trust the information in this letter provides adequate justification against the current planning scheme and ask that the council accepts the submitted documentation as a valid application under LUPAA.

Kind Regards,

Jason Nickerson

Director

Pinnacle Design

17/06/24 Att: Kieran Richards Clarence City Council

Dear Sir/Madam.

PDPLANPMTD-2024/044606 2 Lockheed Place, Cambridge

In response to your correspondence dated 14/06/24 I have addressed your requests as follows:

ITEM COUNCIL REQUEST

C2.5.1 CAR PARKING NUMBERS, A1 To enable us to determine the required number of car parks provided for the use, please specify the anticipated number of employees associated with the proposed use.

C2.6.6 LOADING BAYS, A2

Please specify intended vehicle usage. If designing for heavy vehicles, please provide documentation demonstrating ability to enter and exit the site in a forward direction. Please also demonstrate manoeuvrability of heavy vehicles from Bungana Way onto Lockheed Place and from Lockheed Place to the property, taking into consideration on-street parking.

DEVELOPMENT RESPONSE

Indications from the client are that they currently operate with 3 people in the warehouse area, and that including the office space that employees would not exceed 20 persons, which is in line with Table C2.1 Storage of "1 space per 200m² of the site area or 1 space per 2 employees, whichever is greater" as there are 10 parking spaces provide on the site indicated on sheet A.01.

Amended turning paths for a medium single axle non – articulated vehicle have been shown on sheet A.02 & A.03 as per operational requirements of the proposal.

I trust the provided information addresses the matters identified in the further information request and ask that the council now accept the submitted documentation as a valid application under LUPAA.

Kind Regards,

Steven Haas

Senior Designer